



Backus Rd & West Lake ave - Palm Harbor, FL 34684

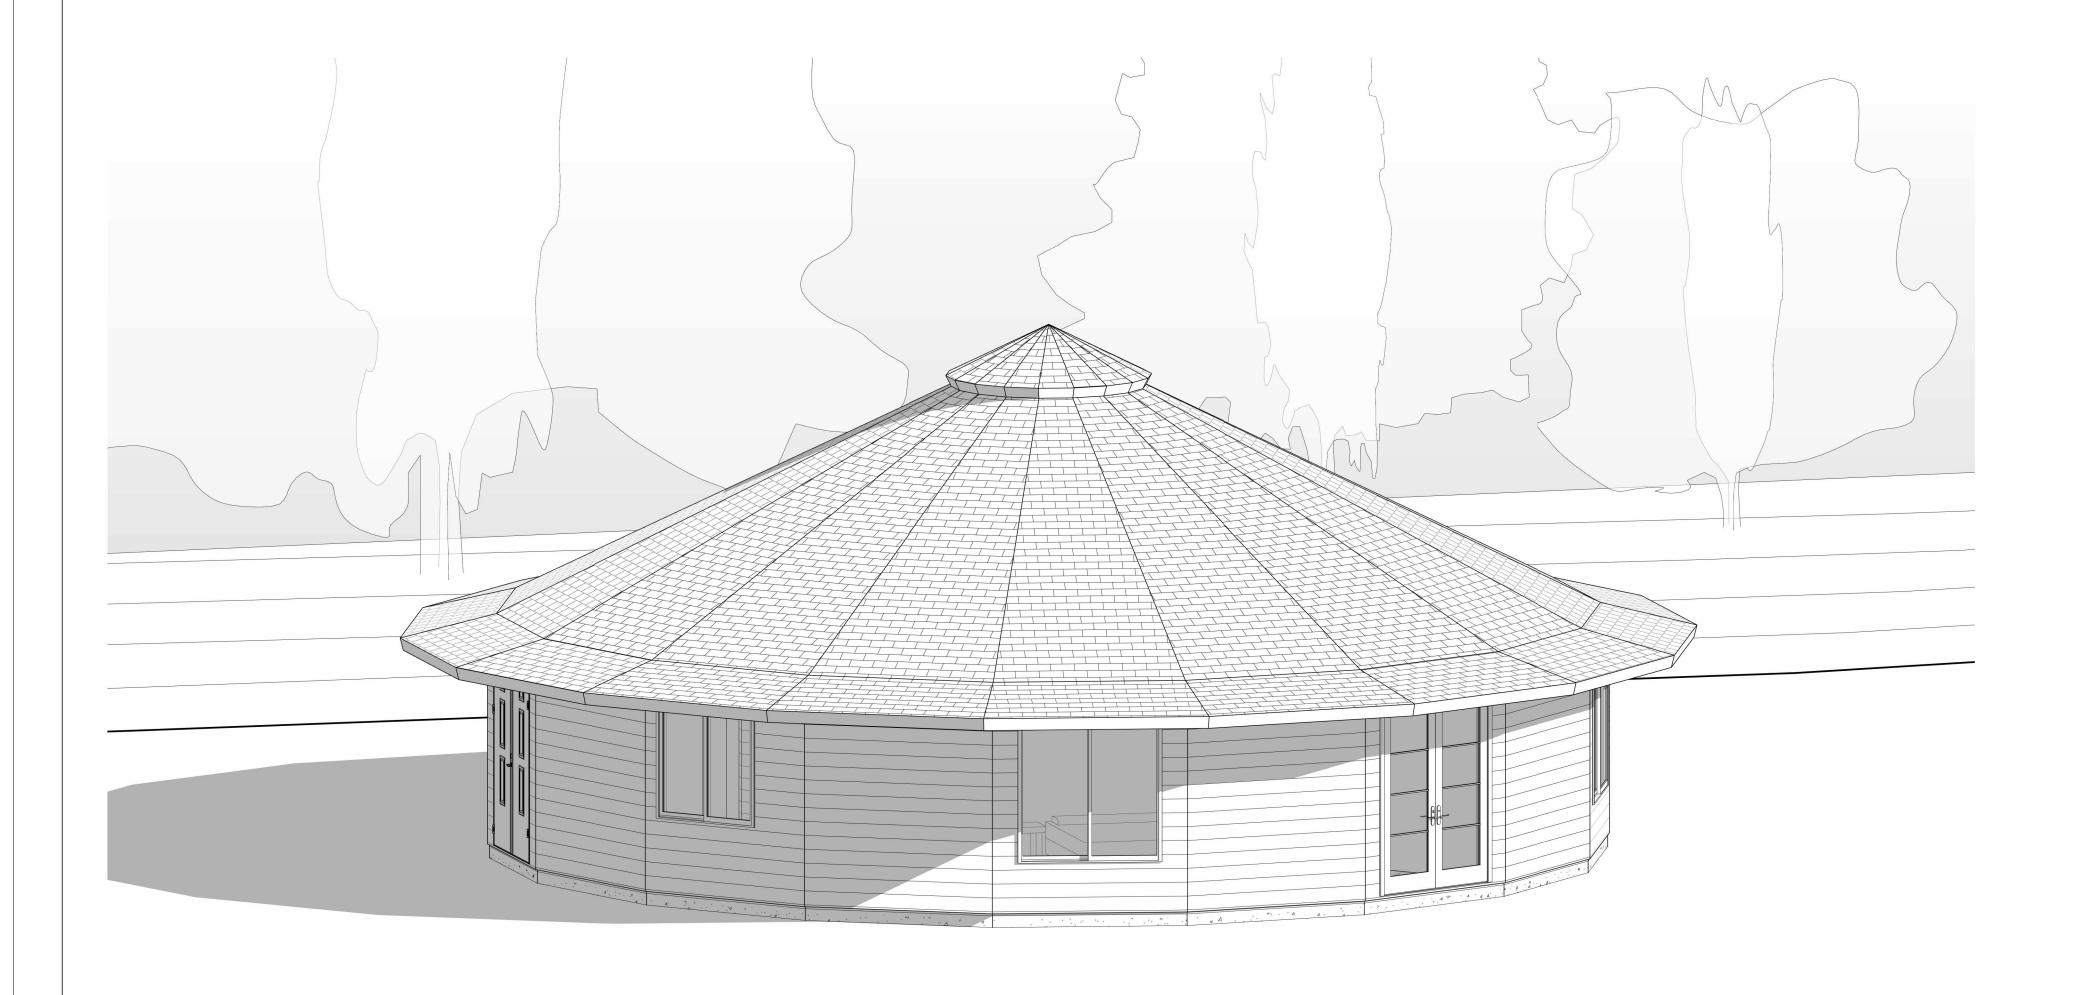

**Deltec Homes Construction Manual:** 



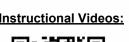















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Jessica Alvarez

1 St 1600 on Slab

Job Number	23027
Drawing Number	2316-714
Project Manager	DO
Drafter	TH

Cover

000

**DESIGN CRITERIA** APPLICABLE CODES

2020 FLORIDA RESIDENTIAL CODE

2020 FLORIDA BUILDING CODE 1. DEAD LOADS A. ROOF B. FLOOR 2. **LIVE LOADS** A. ROOF

B. FLOOR 40 P.S.F. 3. **SNOW LOADS** 0 P.S.F. GROUND SNOW LOAD (Pg) B. FLAT ROOF SNOW LOAD (Pf) 0 P.S.F.

4. WIND LOADS A. DESIGN WIND SPEED 180 MPH a.  $V_{ULT}$ 

145 MPH EXPOSURE CATEGORY WIND LOAD IMPORTANCE FACTOR 1.0 **ENCLOSED** BUILDING CLASSIFICATION

5. SEISMIC LOADS A. SEISMIC DESIGN CATEGORY:

General Structural Notes

The information contained in the structural drawings applies only to the structural design elements associated with the Deltec Homes, Inc. furnished components. This includes the primary structural elements responsible for resisting the lateral and gravity loads as specified by the governing model building code.

20 P.S.F.

15 P.S.F.

30 P.S.F.

2. The general contractor must confirm that existing conditions are compatible with assumptions stated in the production of this design document. Deltec Homes, Inc. must be contacted immediately in the event of any

The general contractor is solely responsible for the installation and erection of temporary shoring and/or bracing during the construction process.

The mechanical, electrical, and plumbing contractors shall coordinate required wall openings with the general

All roof or floor penetrations shall be coordinated with the general contractor. Additional framing shall be furnished and installed by the general contractor.

Deltec Homes, Inc. Is not responsible for inspection or quality control of the erected structure beyond the factory manufactured components.

The foundation for this structure is to be designed by other qualified professionals.

The structural design includes components by Deltec only. Unless otherwise noted, additions to the structure by others shall be designed by qualified persons and shall not impart additional loads to the Deltec structure. Foundation components to be designed & supplied by others. Foundation system information shown is a

minimum requirement only and must be verified by qualified persons. Square footage of rooms shown is approximate floor area only. (closets, tubs, cabinets, etc. Are included in this figure.)

B. Factory Built Wall Panels

All wall studs are SPF no. 2 or better. Studs are 2x4 or 2x6 @ 16" or 24" O.C.

Bottom plates are P.T.S.Y.P. for slab-on-grades construction, SPF no. 2 or better for all other foundations (unless noted otherwise).

4. Drainable house wrap is used for weather-resistant barriers on all standard panels unless noted otherwise. Siding options are pre-installed unless noted otherwise. On non-round structures with loose shipped siding, boards are random length. Therefore, as in routine construction, there will be some butt joints on certain lap runs, arch top, or circle top windows are not trimmed out at the factory. Siding and trim at the area of the arch will be shipped loose to be installed on-site by others.

6. Windows installed in production will be trimmed out for homes that have siding installed at the factory. When only cdx sheathing for walls is specified, or only rough openings for windows are designated (with siding option), window trim is not a standard component. This trim may be purchased as an option. Extension jambs are not included unless otherwise specified.

7. R-5 thermal shield (optional): 1" foam pre-applied to wall panels unless prohibited by local codes or limited by construction needs.

8. Airblock (optional): self-expanding foam gasket installed at the perimeter of all factory-installed plywood

sheathing C. Floor System (If required)

Trusses shall be temporarily braced as required during construction to prevent collapse. The builder is responsible for the design and installation of this bracing. Information regarding temporary truss bracing can be obtained from the "Wood Truss Council of America BCSI-B1 Guide for Handling, Installing, Restraining, and Bracing of Wood Trusses".

Truss members shall be permanently braced with "t-braces", continuous linear braces, and diagonals as indicated on the sealed truss designs and truss layout drawings, or as required by the "Wood Truss Council of America BCSI-B1 Guide for Handling, Installing, Restraining, and Bracing of Wood Trusses". 3. Pre-manufactured wood truss top chords shall be fully sheathed and bottom chords shall have rigid ceilings

or lateral bracing applied, unless otherwise indicated by the sealed truss designs. Trusses designed as required by site-specific loading conditions.

Precut 5/8" CDX plywood sheathing underlayment provided by Deltec supported by web-tec open web floor trusses at 24" O.C. maximum.

Required second layer of 5/8" sheathing not provided by Deltec.

Trusses are SYP no. 1 or better.

Structural steel floor plates with assembly hardware provided by Deltec. Structural steel pipe floor pole assembly with hardware provided by Deltec (as required).

D. Roof System

1. Trusses shall be temporarily braced as required during construction to prevent collapse. The builder is responsible for the design and installation of this bracing. Information regarding temporary truss bracing can be obtained from the "Wood Truss Council of America BCSI-B1 Guide for Handling, Installing, Restraining, and Bracing of Wood Trusses".

Do not remove erection jig until sheathing is fully installed! See the construction manual for details. Truss members shall be permanently braced with "t-braces", continuous linear braces, and diagonals as indicated on the sealed truss designs and truss layout drawings, or as required by the "Wood Truss Council of America BCSI-B1 Guide for Handling, Installing, Restraining, and Bracing of Wood Trusses".

4. Pre-manufactured wood truss top chords shall be fully sheathed, and bottom chords shall have rigid ceilings or lateral bracing applied unless otherwise indicated by the sealed truss designs.

Trusses designed as required by site-specific loading conditions.

Precut 3/4" CDX plywood sheathing, provided by Deltec. Trusses are SYP no. 1 or better.

Roofing underlayment and button cap nails, if required, provided by Deltec, unless included in the optional classic metal roof package.

Structural steel compression ring and tension collar with high strength assembly bolts provided by Deltec. (Second tension collar as required by design)

Assembly Hardware 1. Nails for CDX precut plywood floor and roof sheathing and general framing purposes are not included as part of the standard package due to wide regional variations in installation techniques. Deltec recommends 0.131" x 2.5" (8d) ring shank nails for sheathing and 0.131" x 3.25" (16d) nails for general framing. Hot dipped galvanized fasteners are required for exterior deck applications or any application in contact with preservative-treated lumber.

	Structural Specifications		
1	Model	Round - 1600	
2	Foundation	Slab	
3	Number of Levels	1	
4	Roof Overhang	3' - 9"	
5	Additional Struc. Requirements	Highwind/Seismic	
6	Wall Height - Level 1	9ft	
7	Wall Thickness	2x6	
8	R-5 Thermal Shield	No	
9	Air Block	No	
10	Insulated Header	No	
11	Wood Ceiling	No	
12	FrameGuard	Yes	
13	Siding - Level 1	Fiber Cement	
14	Roof Finish	None	
15	2nd Sill Plate - Level 1	No	
16	Delkote - Level 1	Factory Machine Finish	

Gross Building Area			
Level	Area Type	Area	
Level 1	Gross Building Area	1678 SF	
Grand total		1678 SF	

Room Schedule		
Room Area		
Heated Level 1		
Bath #2	97 SF	
Bedroom #2	209 SF	
Bedroom Suite	262 SF	
En Suite	122 SF	
Entry	97 SF	
Kitchen/Dining	364 SF	
Laundry	36 SF	
Living Area	297 SF	
Office	118 SF	
W.I.C.	42 SF	
Heated	1645 SF	
Total Square Footage	1645 SF	

Exterior Finish Schedule				
Location	Material	Finish	Color	
Siding	Fiber Cement	Textured	TBD	
Corner Trim	Engineered Wood	Textured	TBD	
Window Trim	Engineered Wood	Textured	TBD	
Soffit	Engineered Wood	Textured	TBD	
Fascia	Engineered Wood	Textured	TBD	



NO.	Description	Date
Pre	New Sketch	7/17/2023
0	Initial Plan	8/8/2023
1	Revision 1	8/22/2023

Description

Jessica Alvarez


1 St 1600 on Slab

23027
2316-714
DO
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Notes

001

Scale



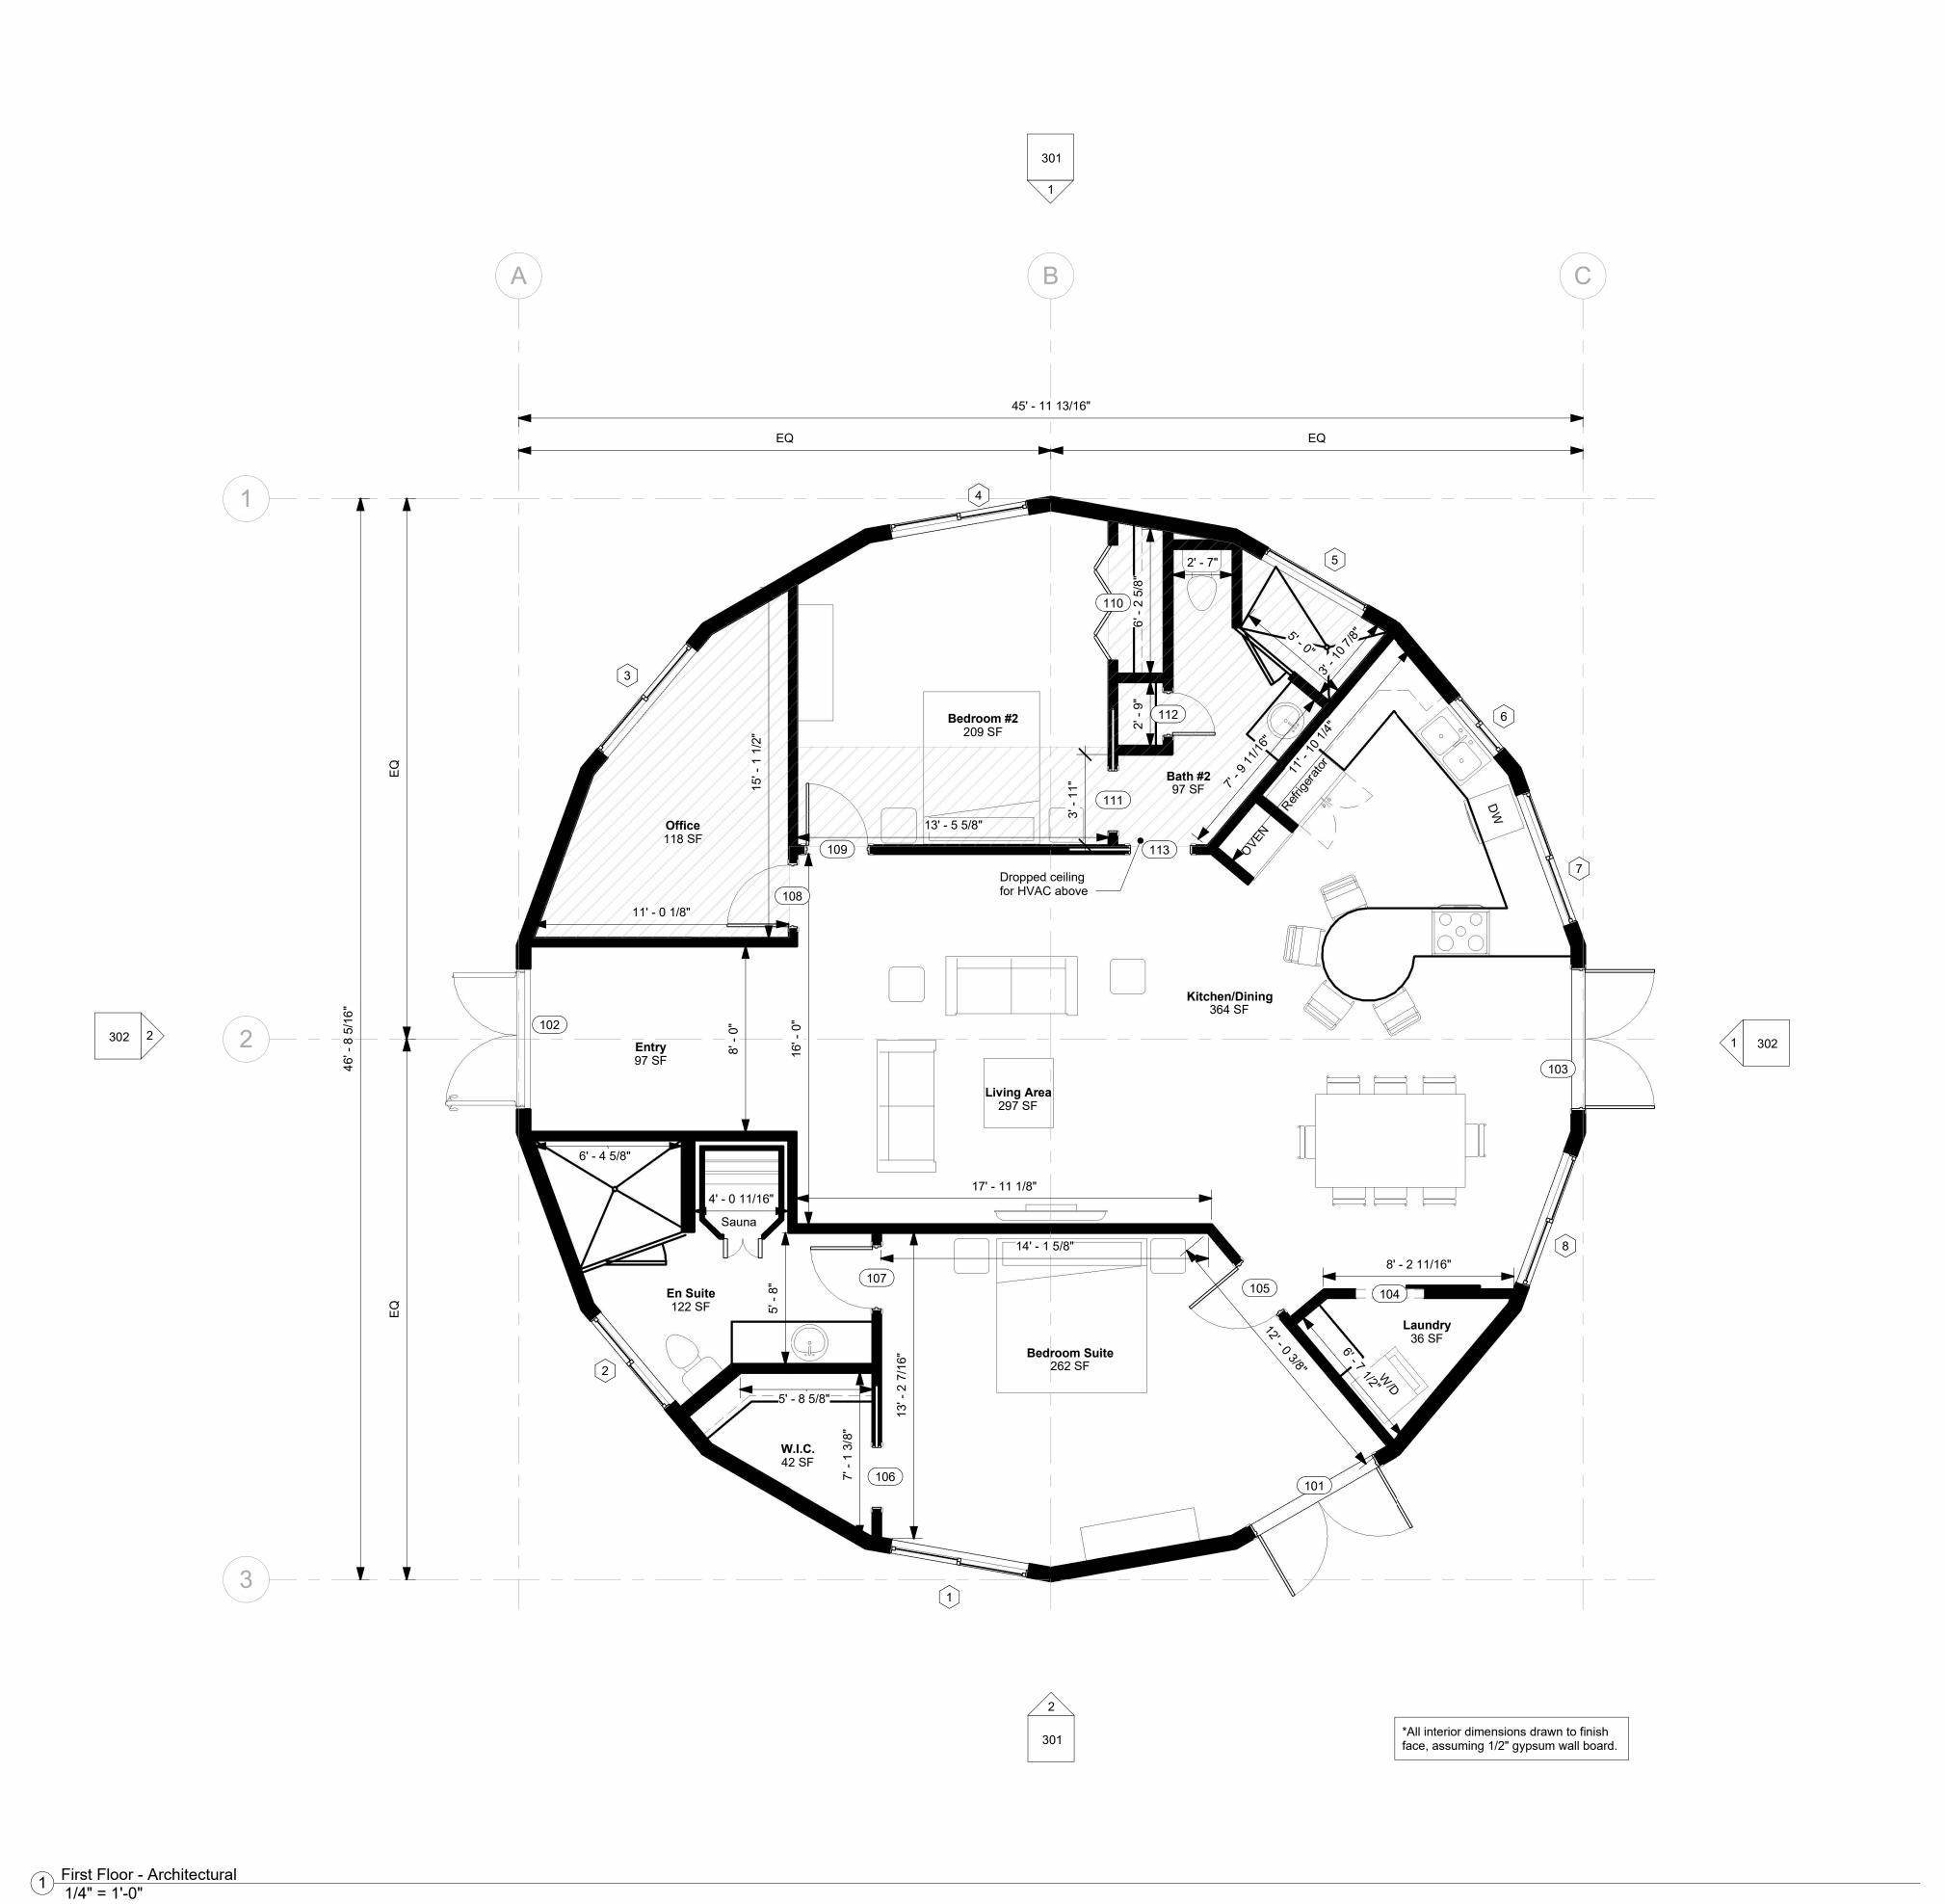


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1 St 1600 on Slab

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Drafter	TH

First Level Arch. Plan

101-A

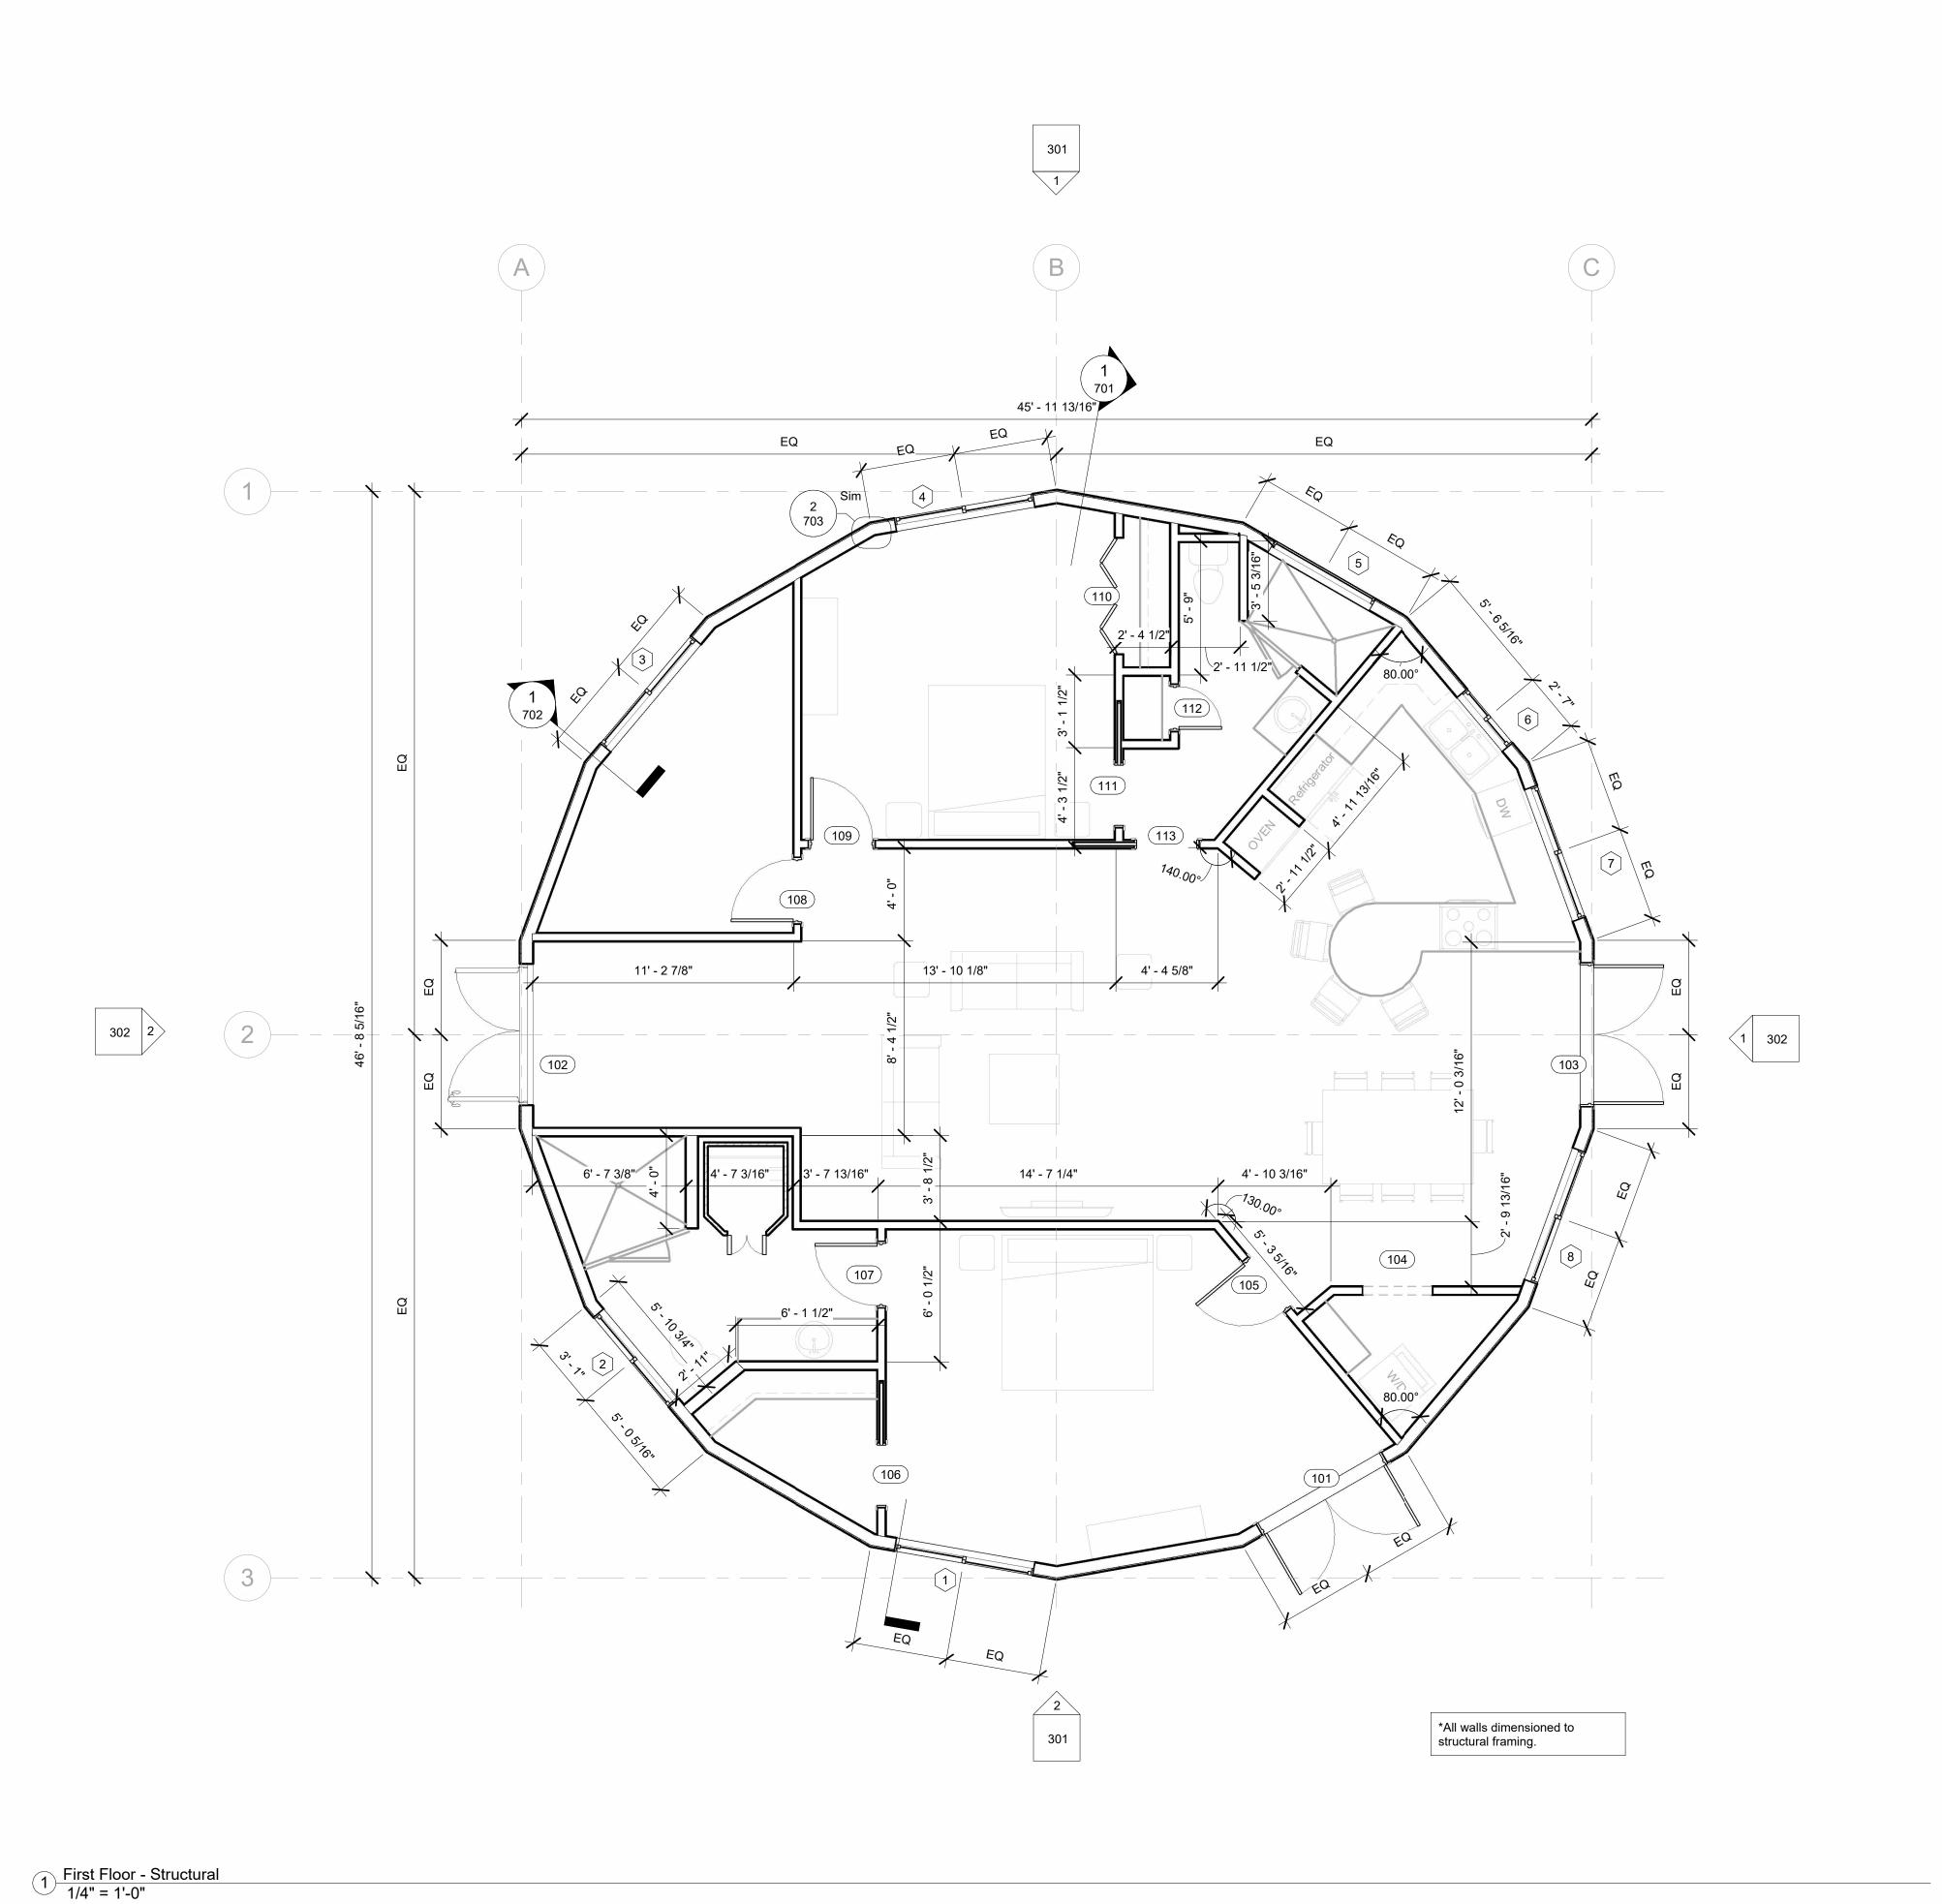

deltec homes



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1 St 1600 on Slab

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	Drafter	TH

First Level Struct. Plan

101-S

e 1/4" = 1'-0"

Window Schedule - By Others				
Owner/Contractor responsible for meeting egress & glazing codes for all windows/doors by others				
Mark	Size Shown on Plan	RO - TBD	Head Height	
1	6' - 0" x 6' - 0"	x	8' - 0 1/2"	
2	5' - 0" x 5' - 0"	x	8' - 0 1/2"	
3	6' - 0" x 6' - 0"	x	8' - 0 1/2"	
4	6' - 0" x 6' - 0"	x	8' - 0 1/2"	
5	5' - 0" x 2' - 0"	x	8' - 0 1/2"	
6	3' - 0" x 4' - 6"	x	8' - 0 1/2"	
7	6' - 0" x 4' - 6"	x	8' - 0 1/2"	
8	6' - 0" x 6' - 0"	x	8' - 0 1/2"	
Grand total: 8				

Size Shown on Plan	RO - TBD
6' - 0" x 8' - 0"	X
6' - 0" x 8' - 0"	X
6' - 0" x 8' - 0"	X
	6' - 0" x 8' - 0"

Mark	Size Shown on Plan	From Room	To Room
104	3' - 0" x 6' - 10"	Kitchen/Dining	Laundry
105	2' - 8" x 6' - 10"	Kitchen/Dining	Bedroom Suite
106	2' - 8" x 6' - 10"	W.I.C.	Bedroom Suite
107	2' - 8" x 6' - 10"	Bedroom Suite	En Suite
108	2' - 8" x 6' - 10"	Living Area	Office
109	2' - 8" x 6' - 10"	Living Area	Bedroom #2
110	5' - 0" x 6' - 10"	Bedroom #2	Bedroom #2
111	2' - 8" x 6' - 10"	Bedroom #2	Bath #2
112	1' - 10" x 6' - 10"	Bath #2	Bath #2
113	2' - 8" x 6' - 10"	Bath #2	Living Area



No.	Description	Date
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1 St 1600 on Slab


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Project Manager	DO
Drafter	TH

Schedules


201

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MI CO.OC.S COORICA

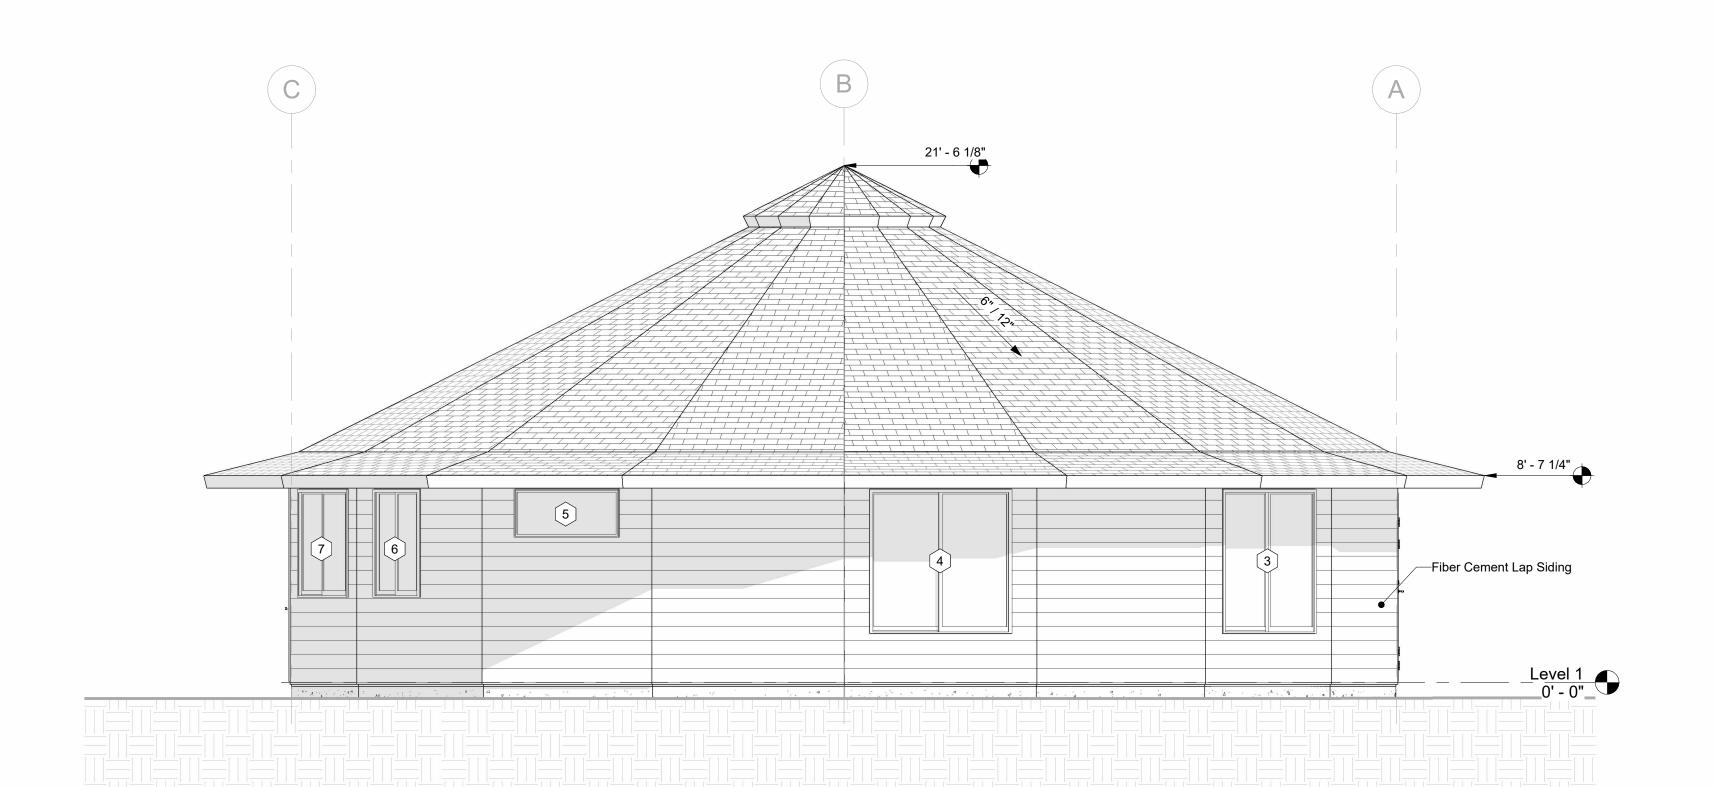

1 North 1/4" = 1'-0"

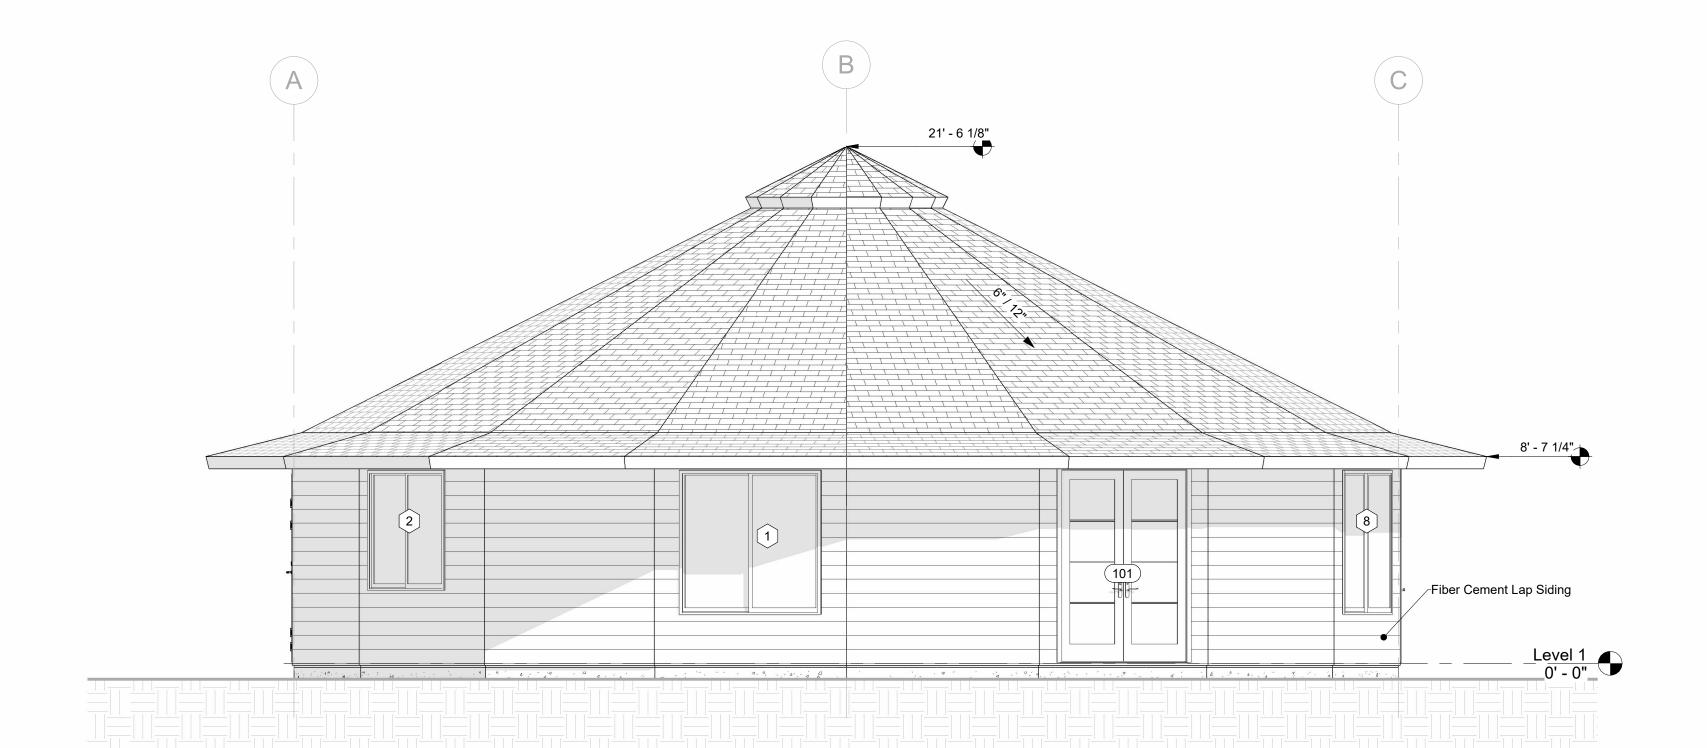

2 South 1/4" = 1'-0"

deltechomes

No.	Description	Date
Pre	New Sketch	7/17/2023
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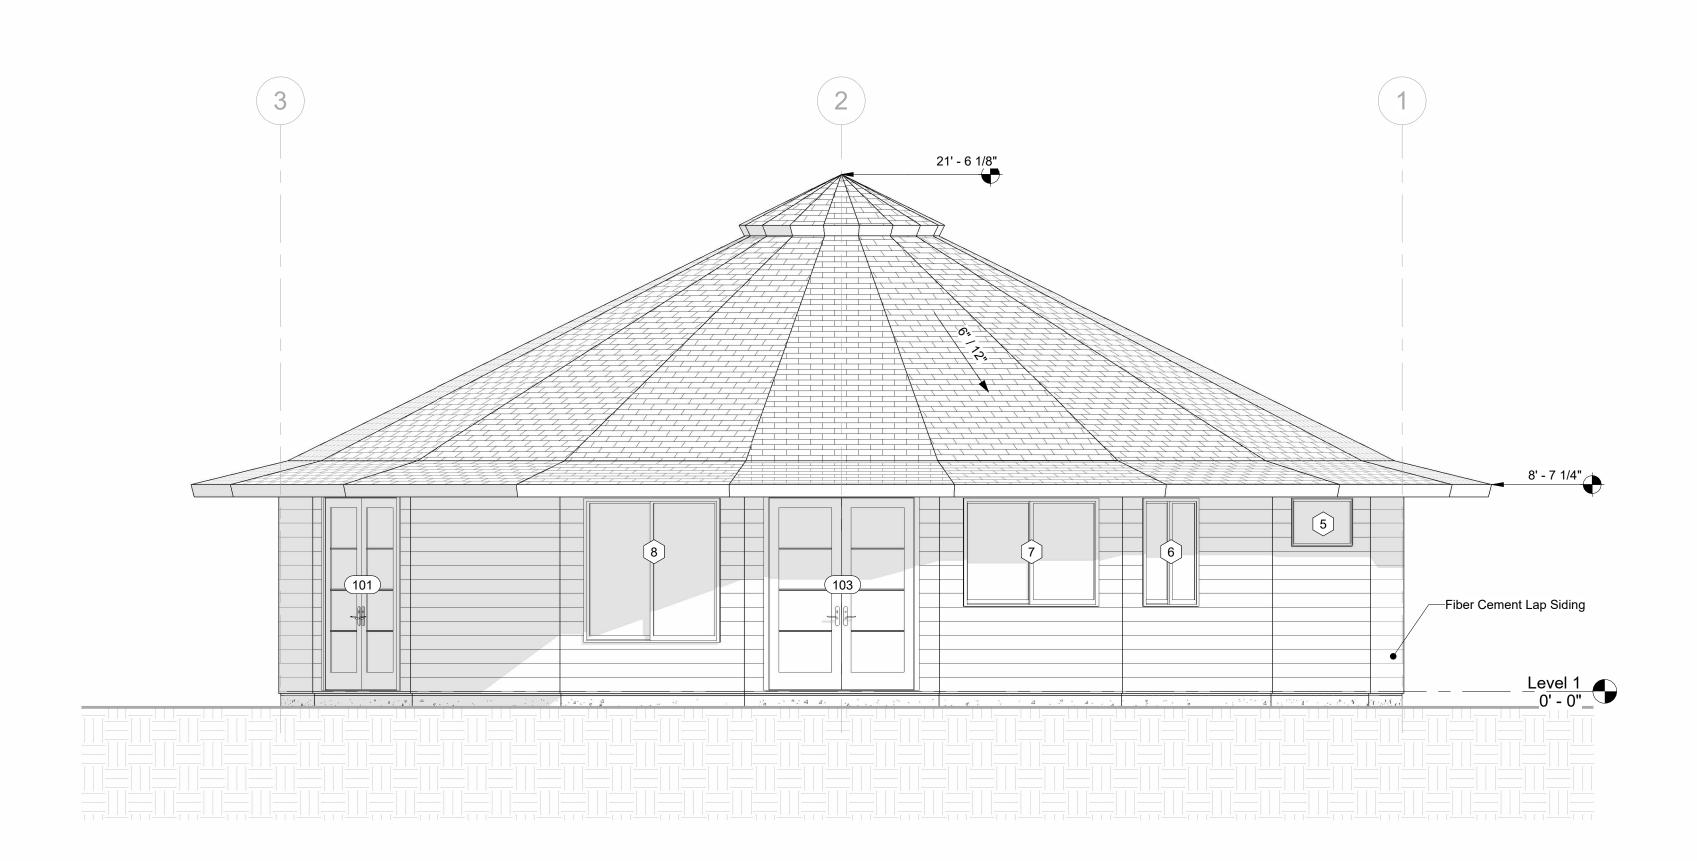
Jessica Alvarez

1 St 1600 on Slab


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	Drawing Number	2316-714
	Project Manager	DO
	Drafter	TH
- 1		

Elevations

301





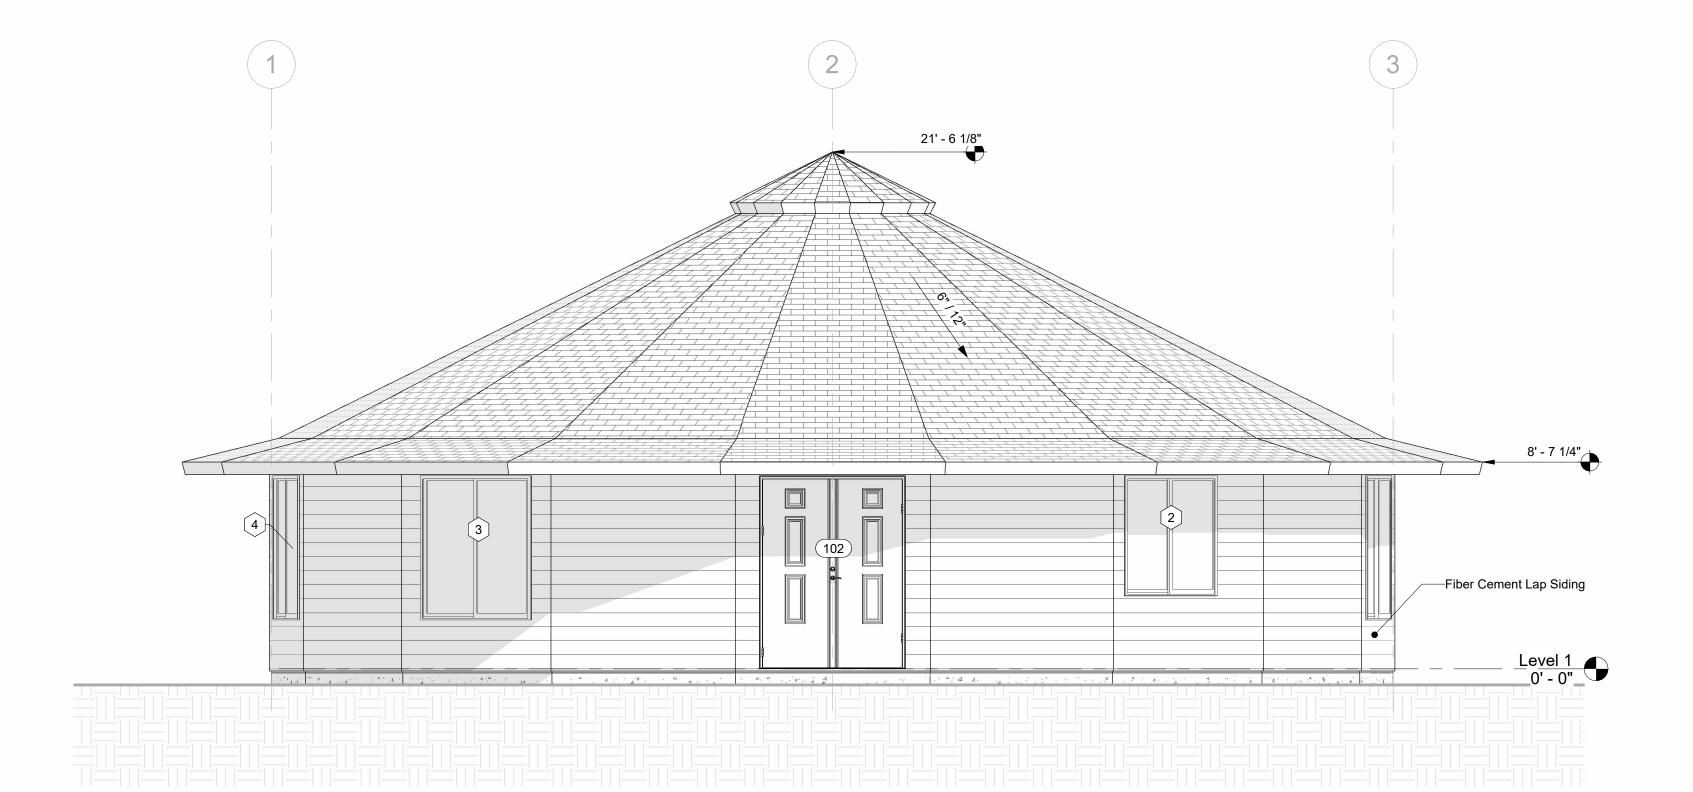

② West / 1/4" = 1'-0"

deltechomes



No.	Description	Date
0	Initial Plan	8/8/2023
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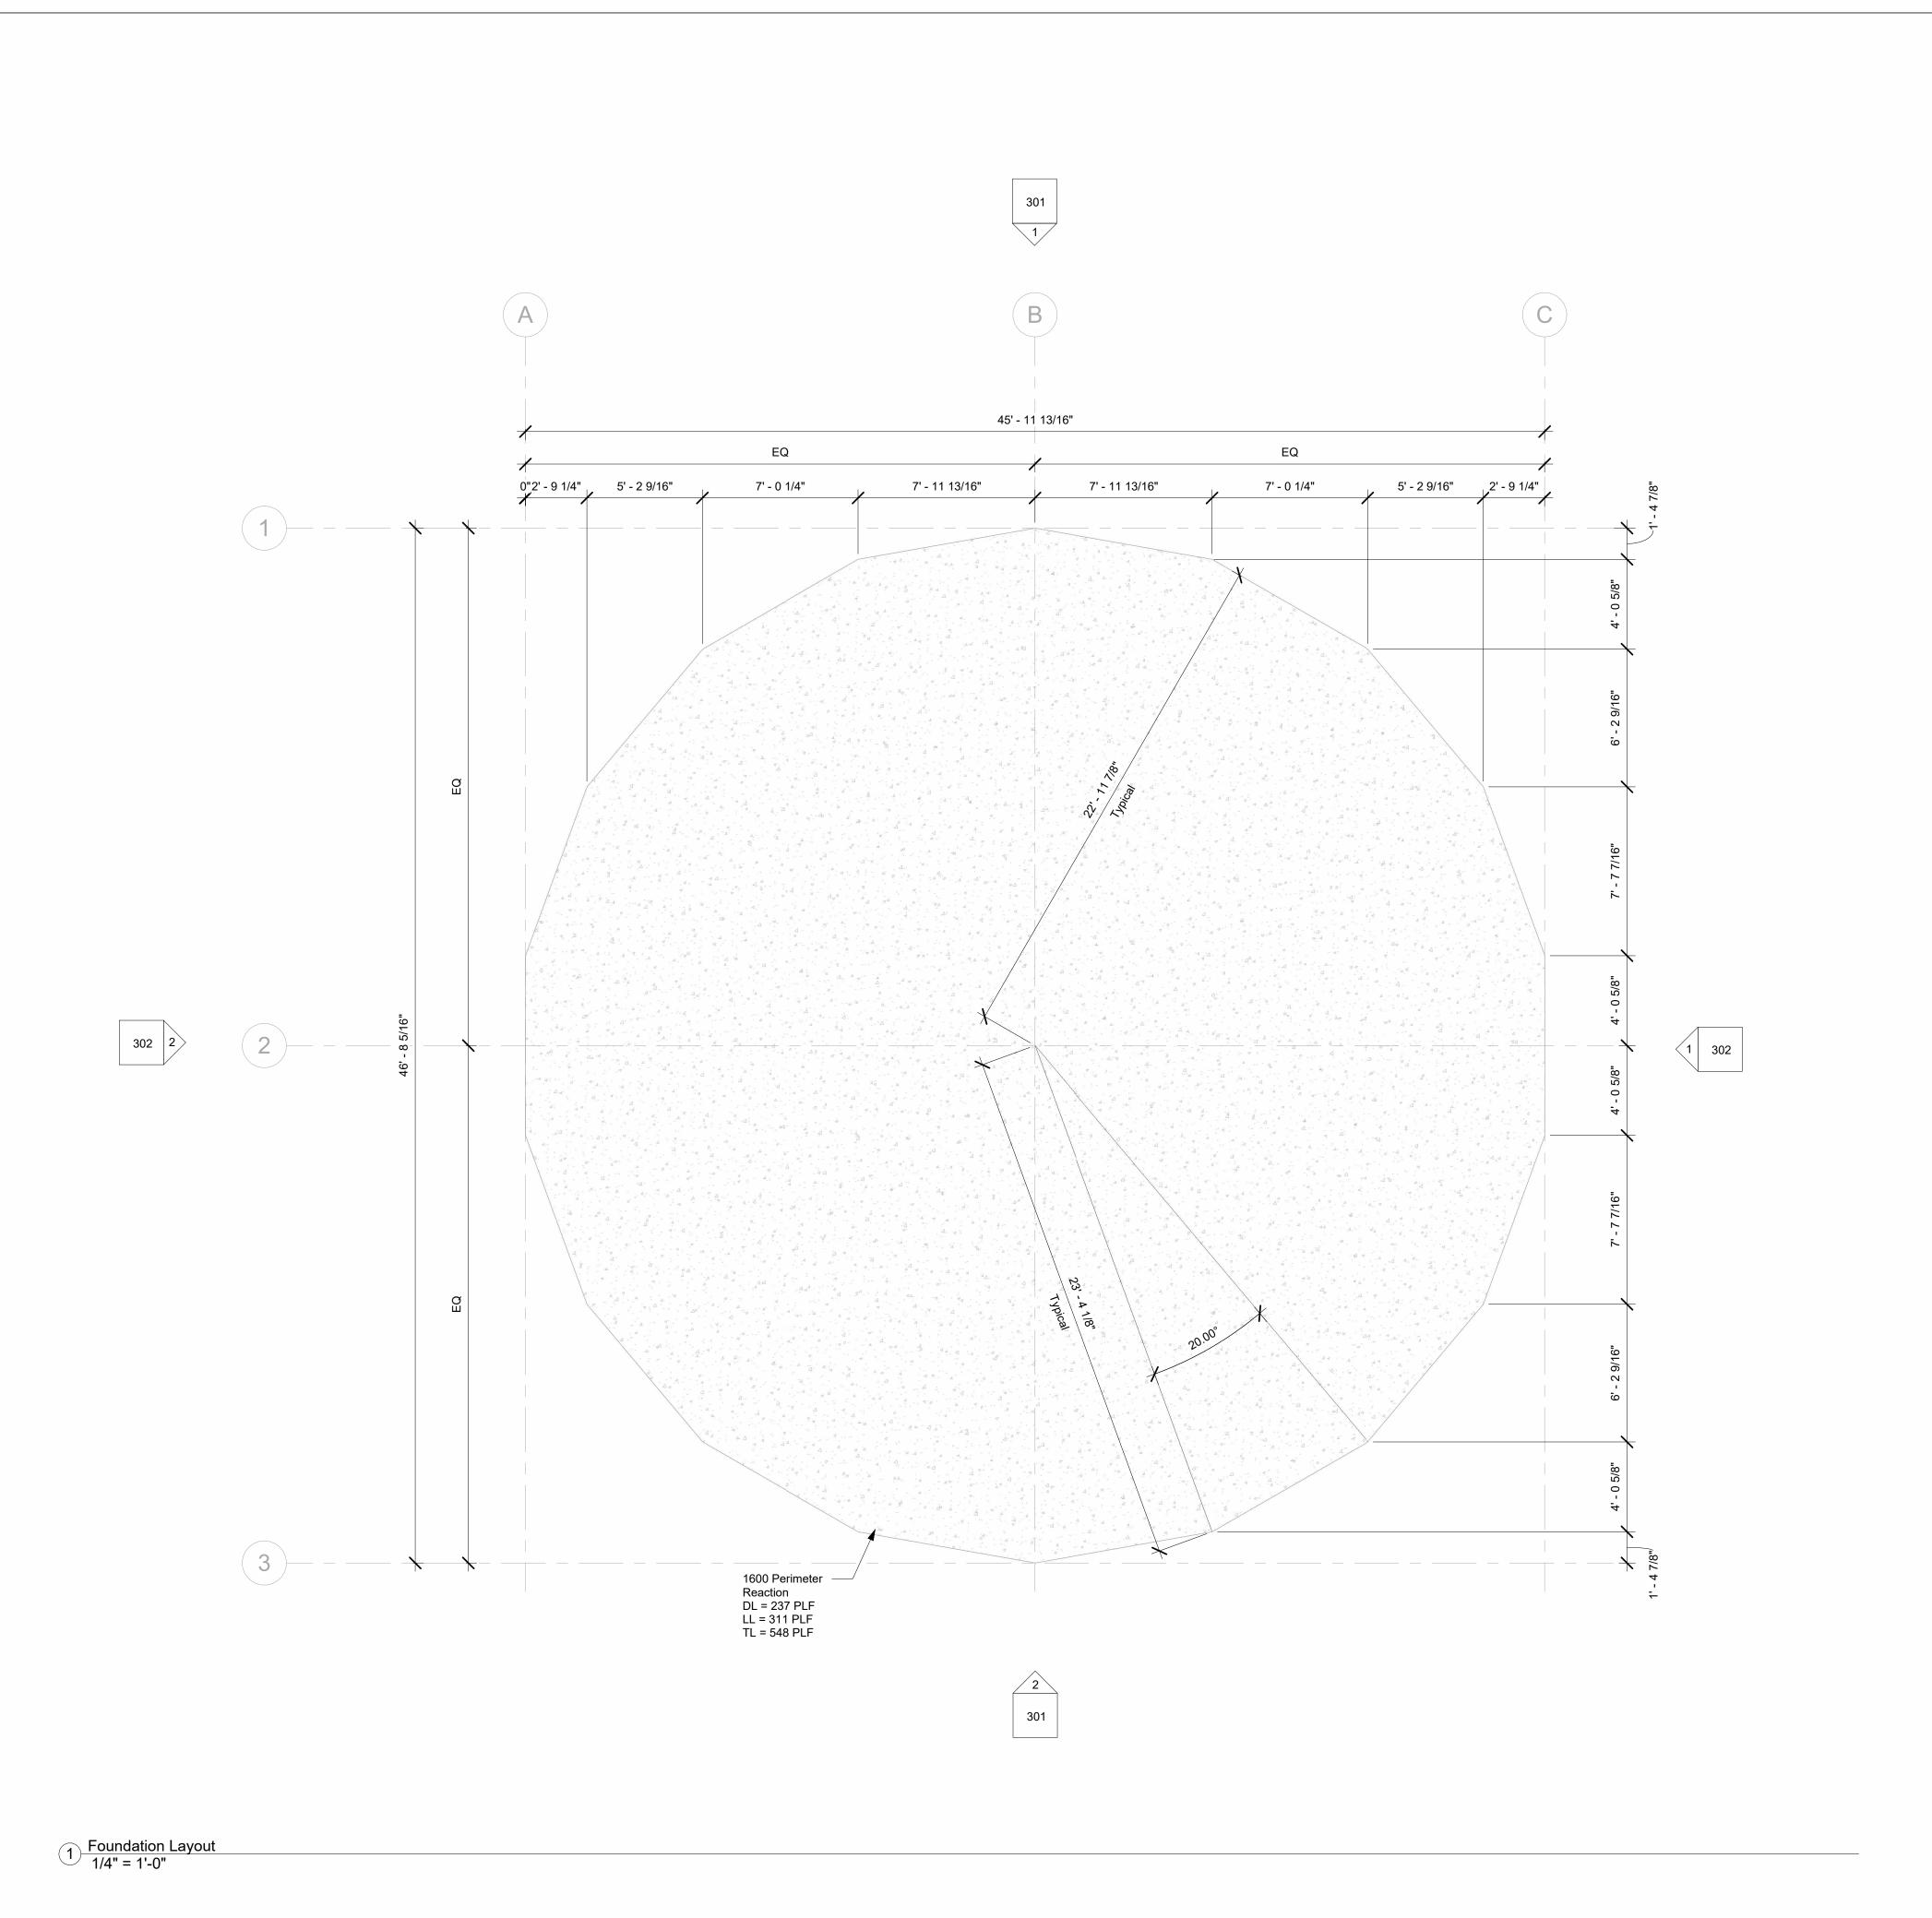
Jessica Alvarez

1 St 1600 on Slab

Job Number	23027
Drawing Number	2316-714
Project Manager	DO
Drafter	TH

Elevations

302



deltec



No.	Description	Date
Pre	New Sketch	7/17/2023
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1	Revision 1	8/22/2023
	-	


Jessica Alvarez

1 St 1600 on Slab

	Job Number	23027
	Drawing Number	2316-714
	Project Manager	DC
	Drafter	T⊦
	-	

Foundation Layout

401

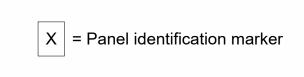



No.	Description	Date
	Initial Plan	8/8/2023
	Revision 1	8/22/2023

1 St 1600 on Slab

Job Number	23027
Drawing Number	2316-714
Project Manager	DC
Drafter	T⊦
	Drawing Number Project Manager

Panel Layout

501

1/4" = 1'-0"

		A	B	C
	1	Н	J K	
302 2		F D C		N 1 302
	3	В	Q R	
			301	


First Floor - Panel Layout
1/4" = 1'-0"


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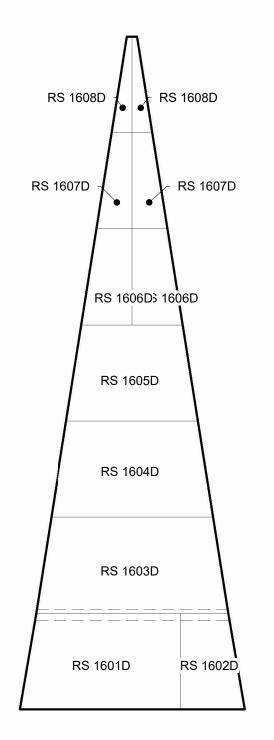






Attach jack truss to hip truss w/ (3)
16d nails at top and bottom chord.

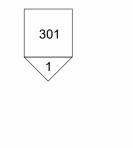301

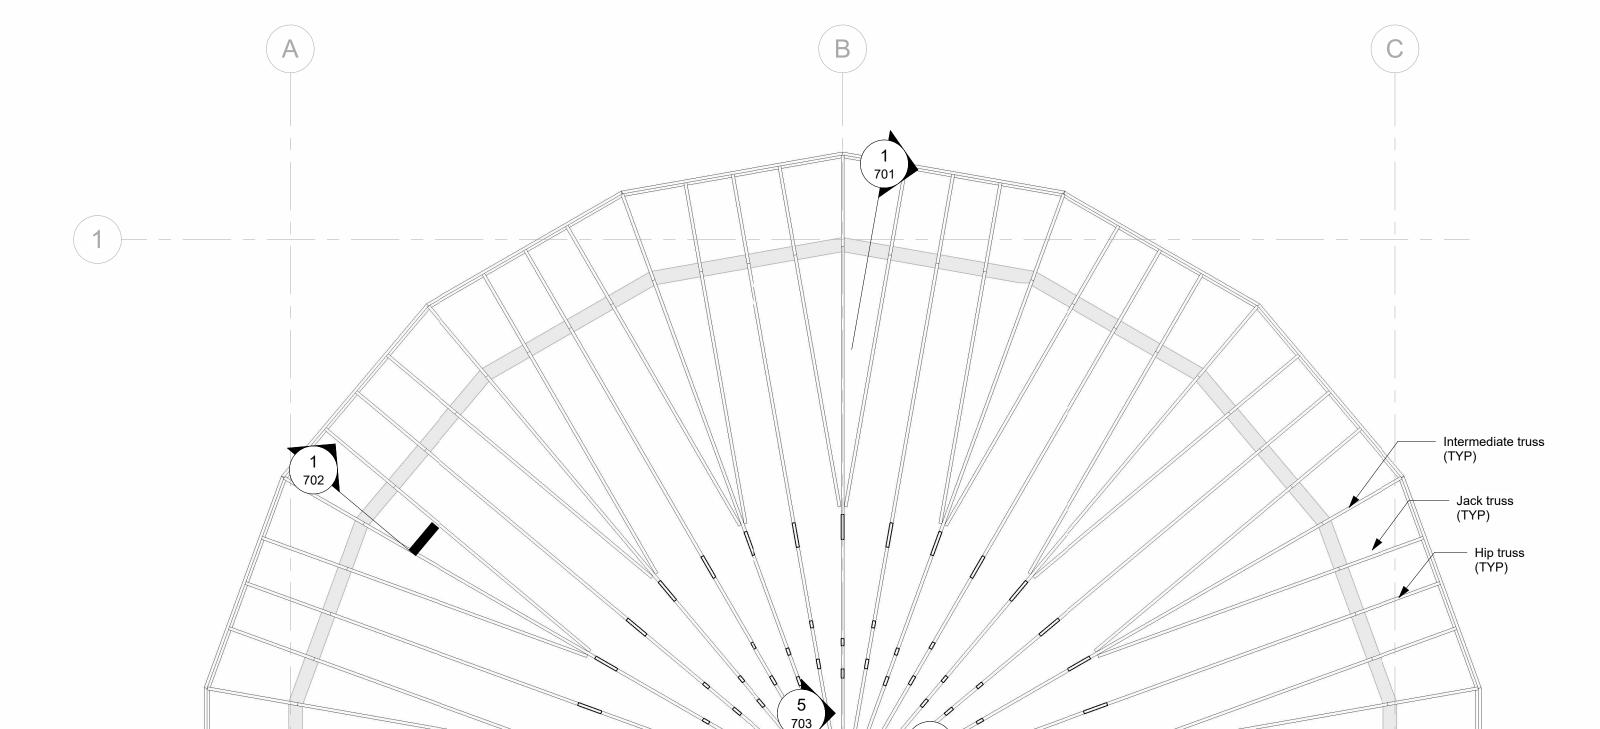

1 302

3-9 Typ Bay Sheathing Layout
1/4" = 1'-0"

No.	Description	Date
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1 St 1600 on Slab


Job Number	23027
Drawing Number	2316-714
Project Manager	DO
Drafter	TH


Roof Framing Layout

601

1/4" = 1'-0"

1 Roof Framing Layout 1/4" = 1'-0"

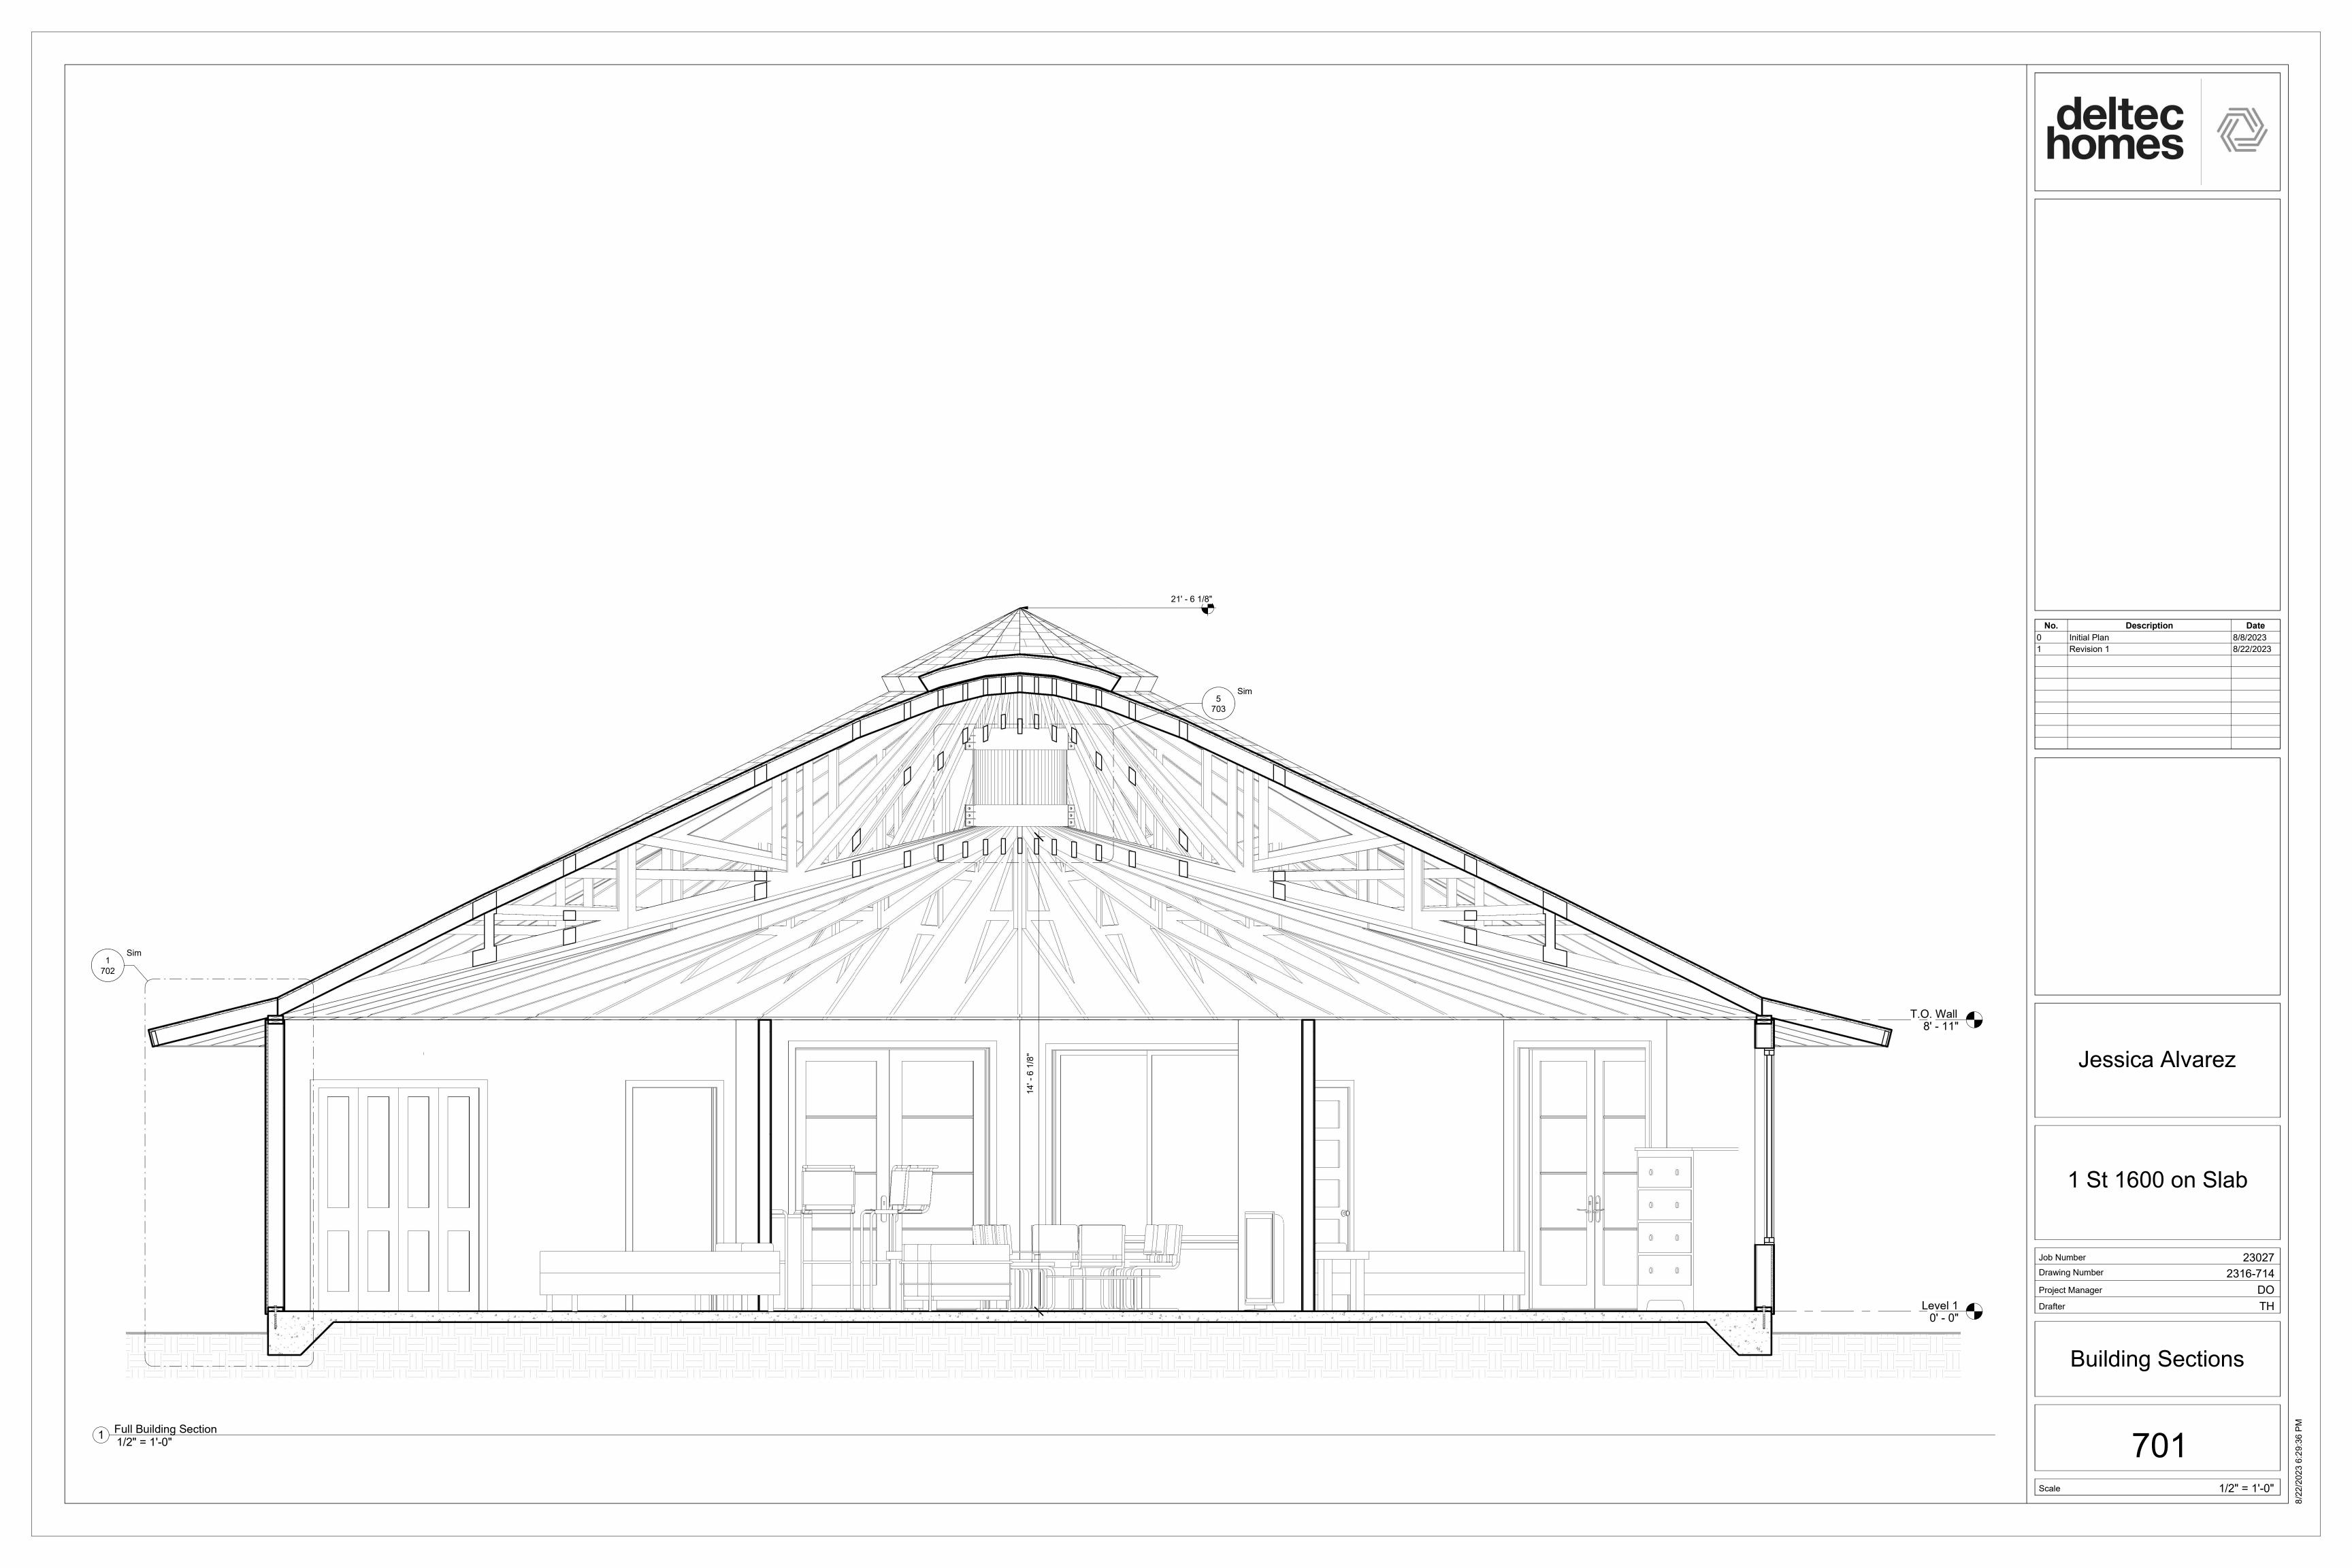

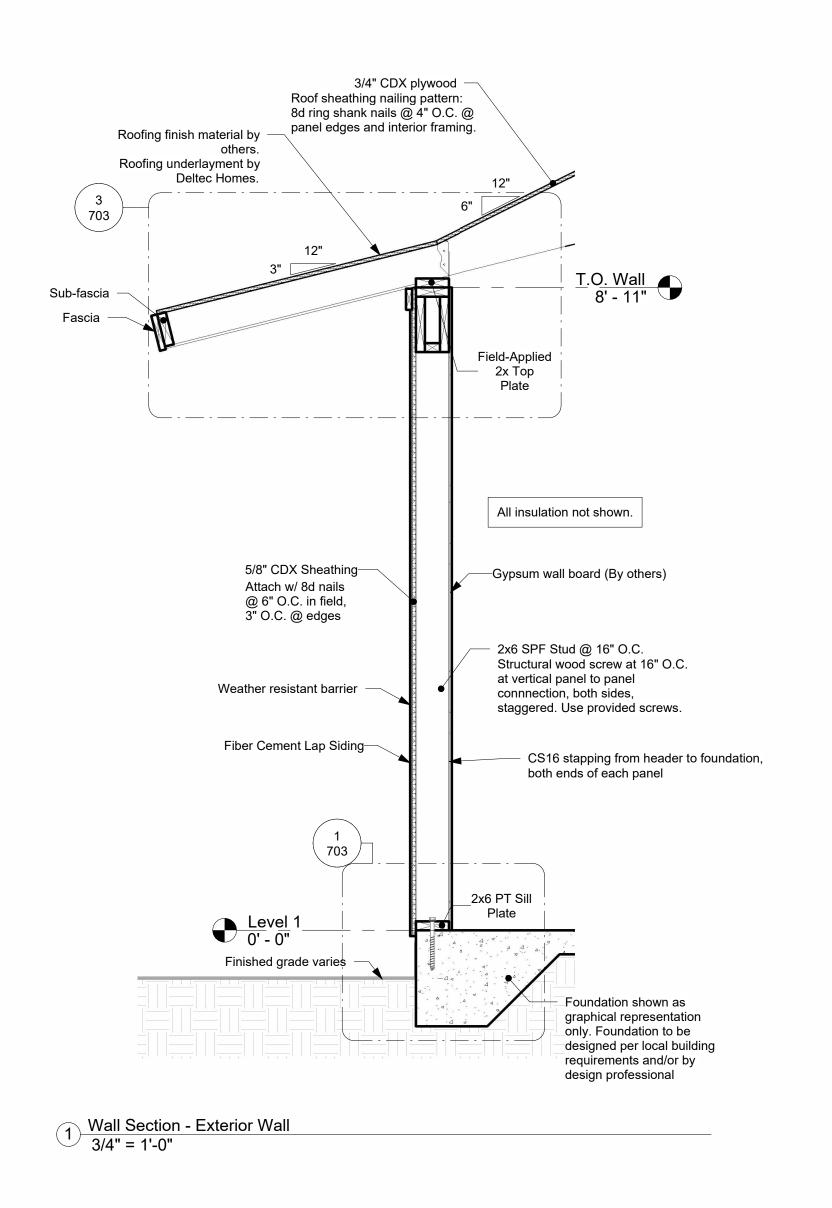





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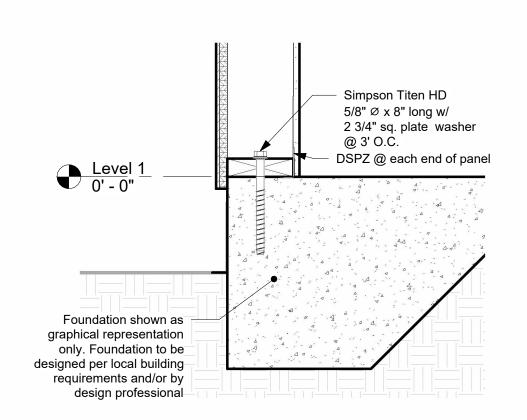
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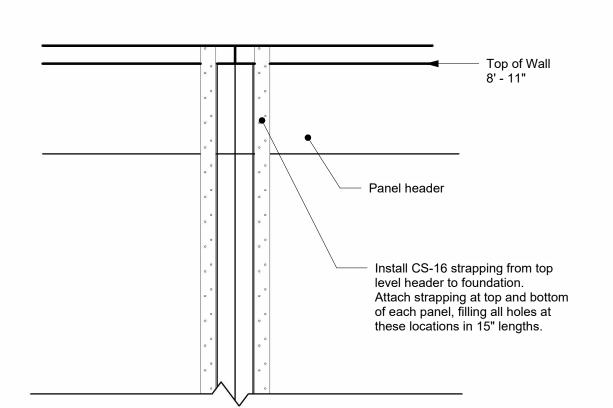
Wall Sections


702

Scale




Sill Plate Connection
1 1/2" = 1'-0"




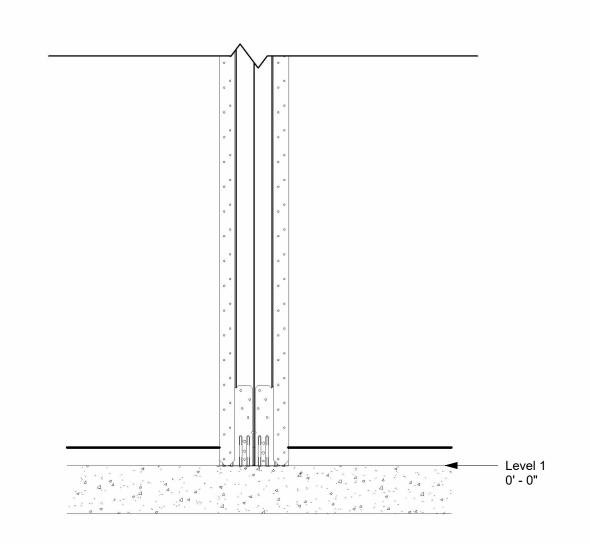


4 Typ. Strapping Detail 1 1/2" = 1'-0"

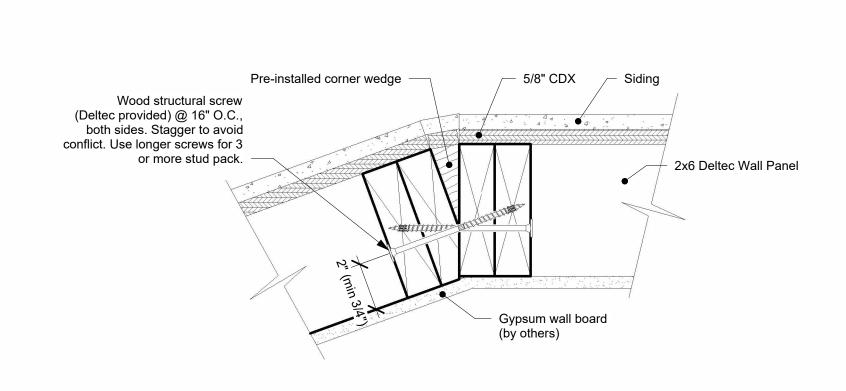


2 Corner Detail - Deltec Wall 3" = 1'-0"

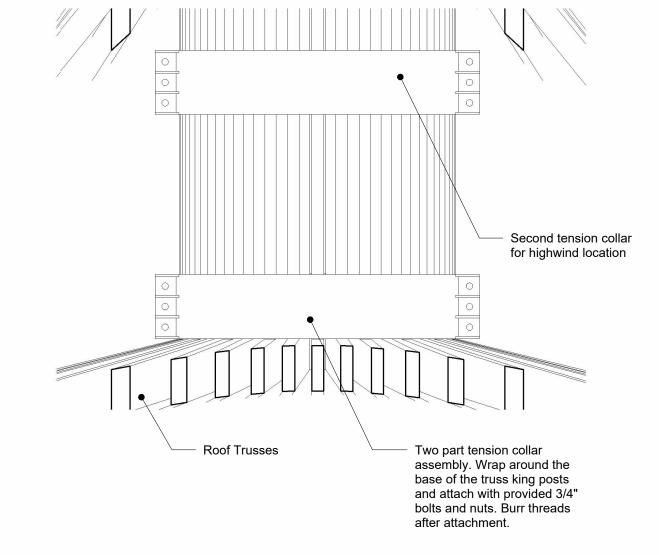


5 Center Assembly 1" = 1'-0"

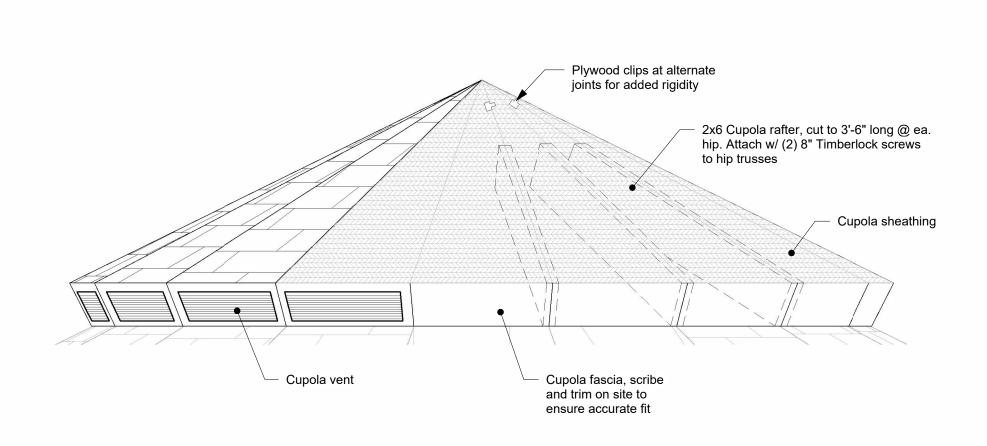


7 Cupola Detail 1" = 1'-0"

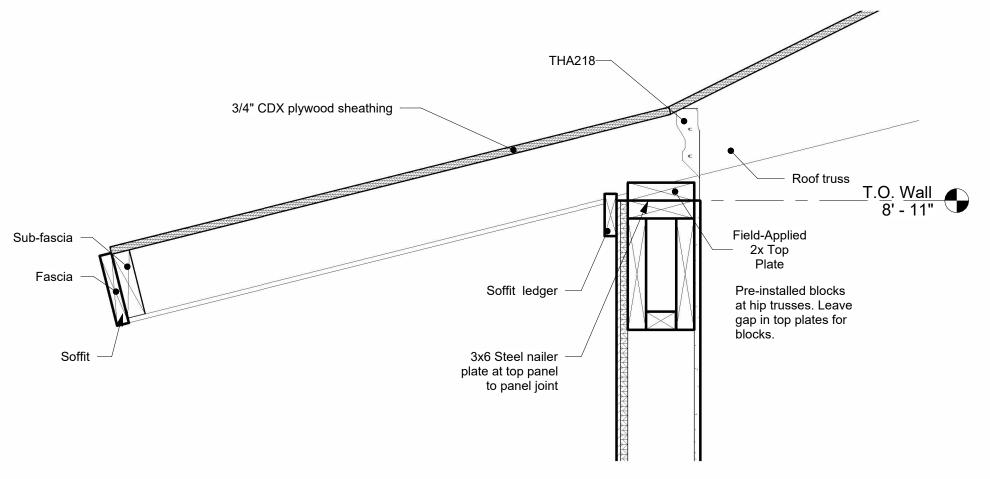

3 Top Plate Connection 1 1/2" = 1'-0"

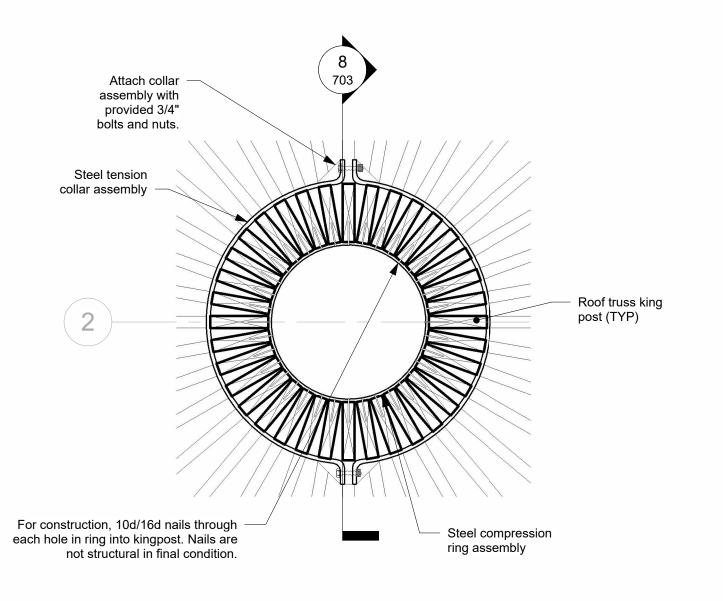

6 Center Assembly - Top View 1" = 1'-0"

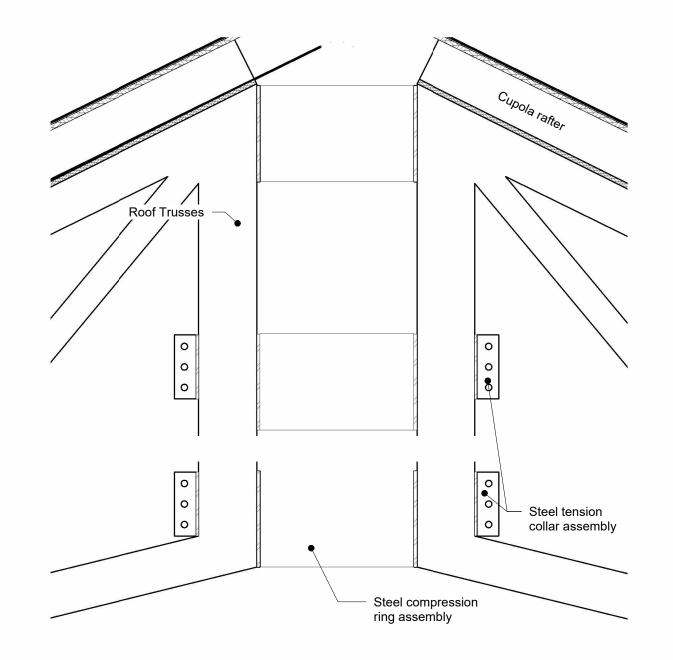

8 Center Assembly - Section Cut
1" = 1'-0"





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**Details** 

703

Scale

As indicated